



1 Plan 1
SCALE 1:200

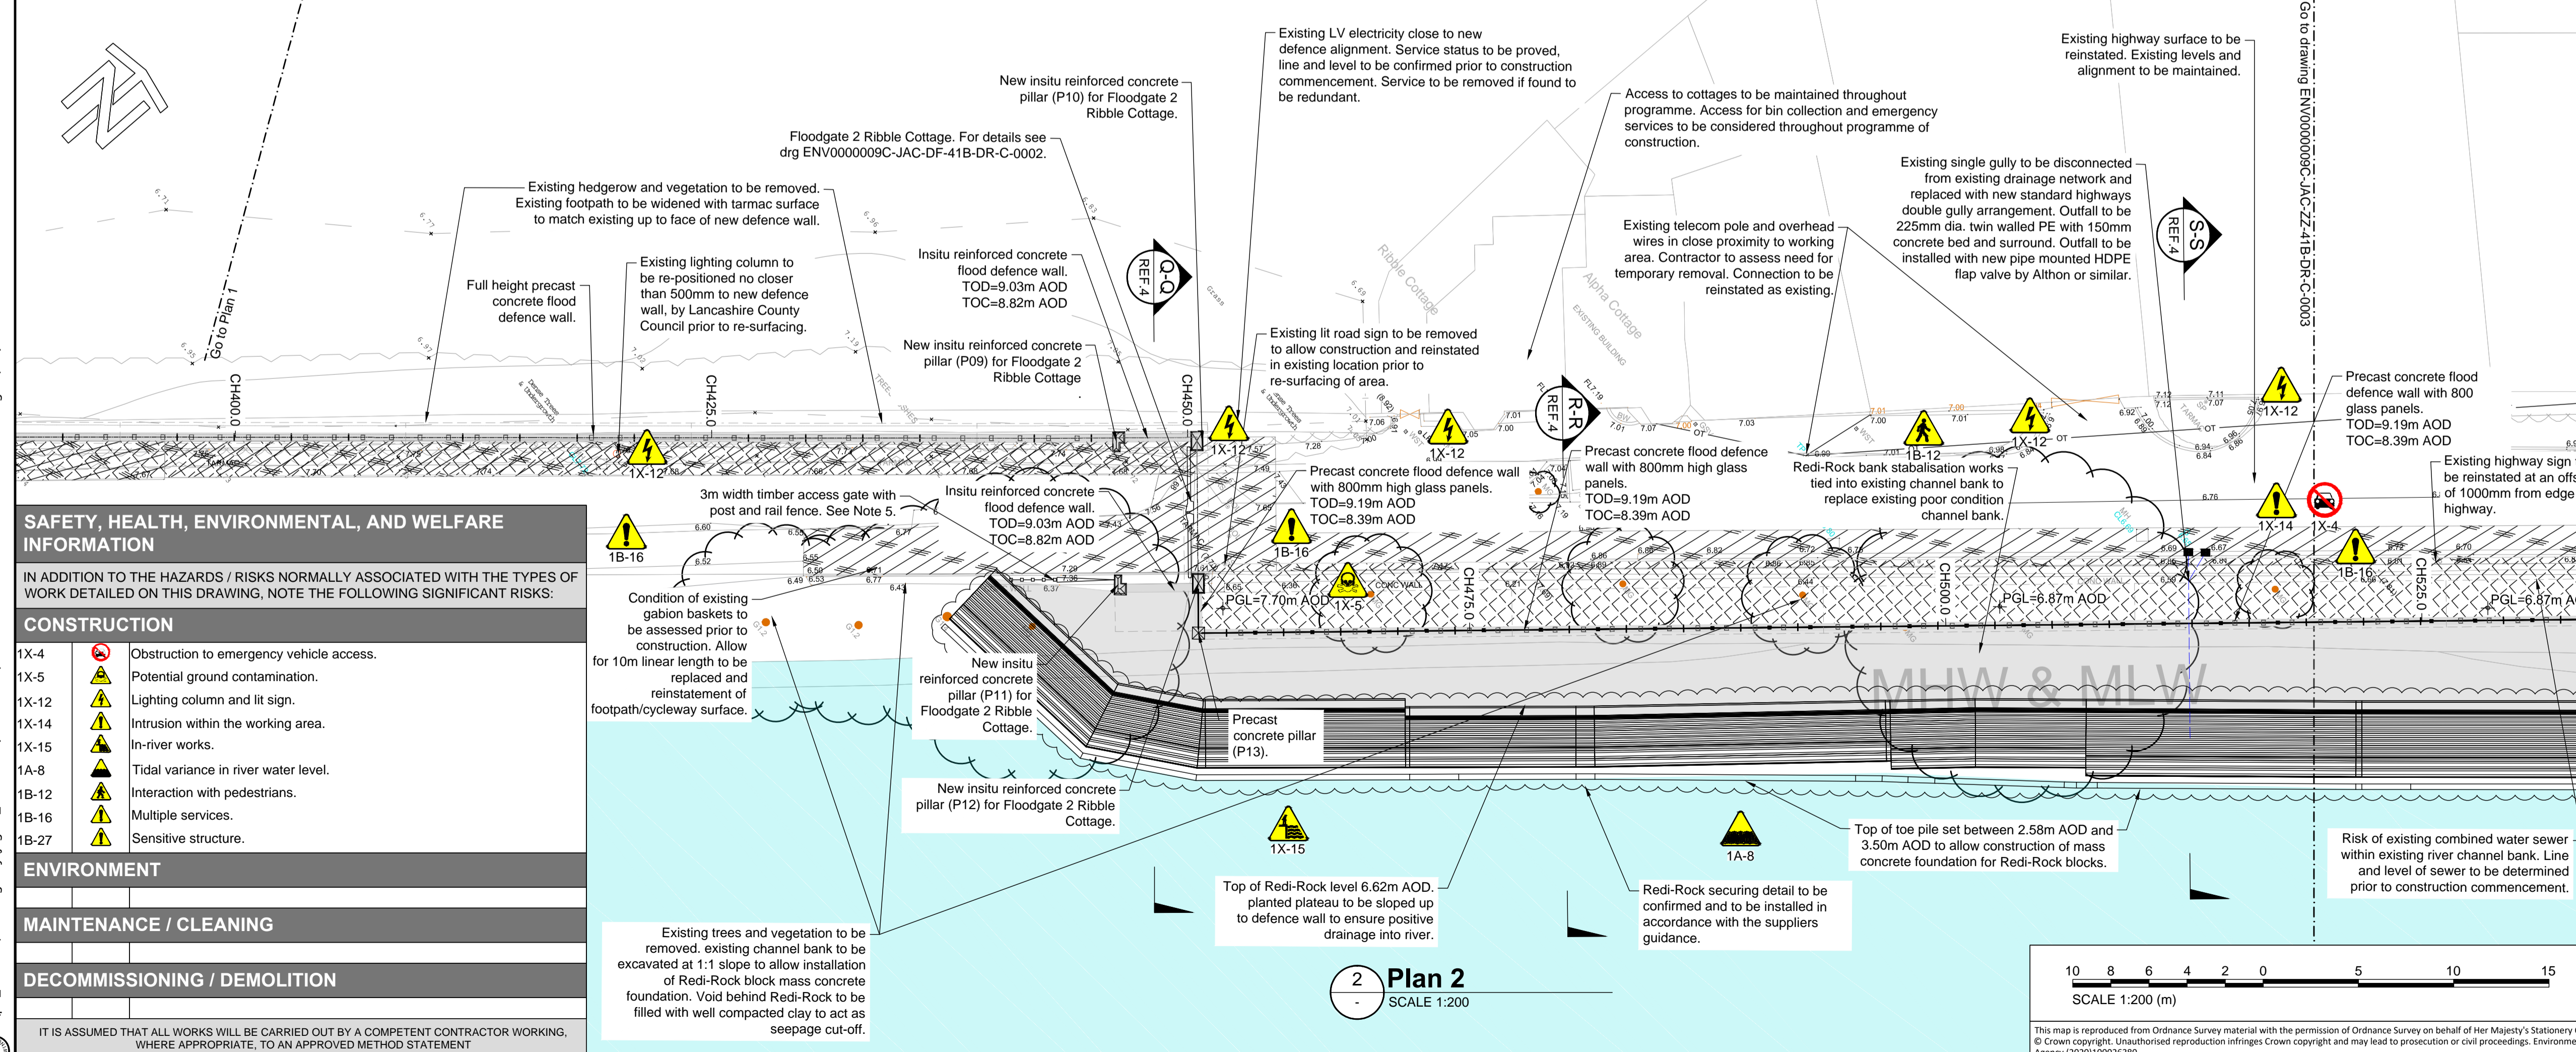

2 Plan 2
SCALE 1:200

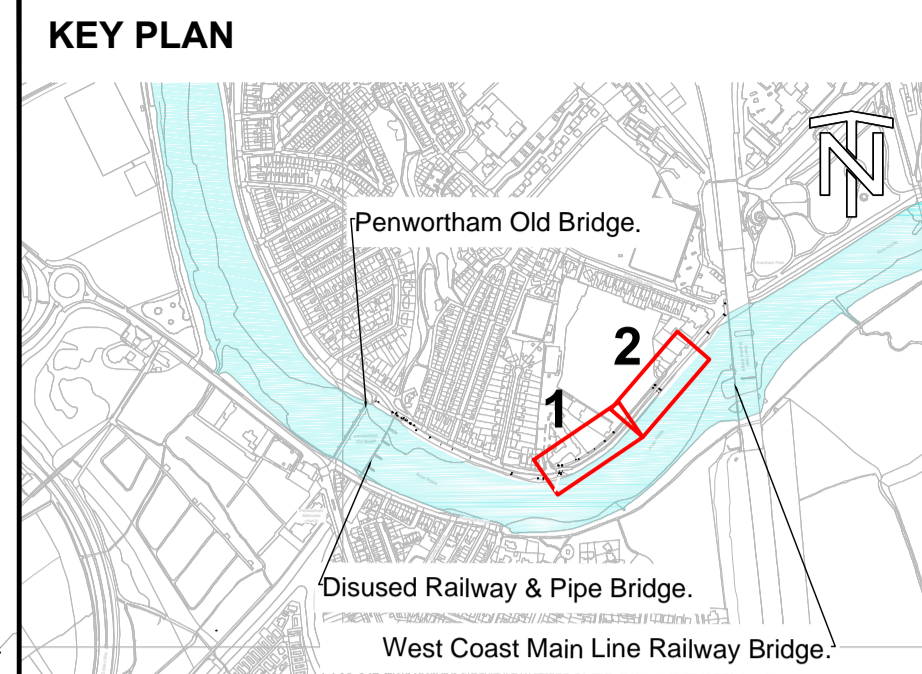

GENERAL NOTES

1. ALL DIMENSIONS ARE IN MILLIMETRES UNLESS NOTED OTHERWISE.
2. ALL LEVELS ARE IN METRES ABOVE ORDNANCE DATUM.
3. ADDITIONAL PRIVATE SERVICES MAY BE PRESENT. ELECTRONIC SCANNING AND TRIAL HOLES ARE REQUIRED BY THE CONTRACTOR TO CONFIRM THE LOCATION OF SERVICES PRIOR TO CONSTRUCTION.
4. OUTFALL LOCATIONS AND FLAP VALVES HAVE BEEN DETERMINED BY REVIEWING DRONE FOOTAGE. THE CONTRACTOR IS RESPONSIBLE FOR CONFIRMING THE EXACT LOCATION OF ALL OUTFALLS AND PRESENCE OF FLAP VALVES WITH FURTHER SITE SURVEY, ELECTRONIC SCANNING AND TRIAL HOLES TO CONFIRM LOCATIONS. THE CONTRACTOR IS RESPONSIBLE FOR ENSURING THAT ALL OUTFALLS ARE FLAPPED WITH A FLAP VALVE IN GOOD WORKING CONDITION. 3M WIDTH SINGLE LEAF LOCKABLE PRESSURE TREATED TIMBER ACCESS GATE, TO BE INSTALLED WITH PRESSURE TREATED TIMBER POST AND RAIL FENCE, TO PREVENT UNAUTHORISED ACCESS TO TOP OF REDI-ROCK BANK. GATE TO HINGE ON POST LOCATED AT TOP OF REDI-ROCK BANK EDGE TO PROVIDE EDGE PROTECTION WHEN OPENED. GATE TO HAVE STOPPER FITTED TO PREVENT IT FROM OPENING BEYOND THE TOP OF THE REDI-ROCK BANK.

REFERENCES

1. DRG ENV000009C-JAC-ZZ-41B-DR-C-0001/0003 AREA 1B GA PLAN SHEET 1/3 OF 3.
2. DRG ENV000009C-JAC-DW-41B-DR-S-0002 AREA 1B CONCRETE GA PLAN SHEET 2 OF 3.
3. DRG ENV000009C-JAC-DZ-41B-DR-C-0010/0011/0012 AREA 1B LONGITUDINAL SECTION SHEET 3/4/5 OF 6.
4. DRG ENV000009C-JAC-DZ-41B-DR-C-0004/0005/0006 AREA 1B SECTIONS AND DETAILS SHEET 4/5/6 OF 7.
5. DRG ENV000009C-JAC-DW-41X-DR-S-0001 AREA 1 WALL TYPICAL DETAILS.
6. DRG ENV000009C-JAC-ZZ-00-DR-RD-0001/0002 HIGHWAY TYPICAL DETAILS SHEET 1/2 OF 2.
7. DRG ENV000009C-JAC-ZZ-DR-EN-0001 ENVIRONMENTAL CONSTRAINTS PLAN.
8. DRG ENV000009C-JAC-ZZ-DR-L-0004/0005/0006 LANDSCAPE MASTERPLAN AREAS 1 AND 2 SHEET 3 FIGURE 1.6/1.7/1.8.
9. AREA 1B REINFORCEMENT DETAILS SHEET TBC.
10. DRG ENV000009C-JAC-ZZ-41B-DR-C-0001/0002 AREA 1B FLOODGATE 1 AND 2 PLAN AND SECTIONS.



TOD= TOP OF DEFENCE
TOC= TOP OF CONCRETE
PGL= PROPOSED GROUND LEVEL


CO2	2021-06-25	For Construction	TK	NP	SM	MW
P01	2020-11-06	Full Business Case	TK	APR	NP	MW
Rev	Rev. Date	Purpose of revision	Orig	Check'd	Rev'd	Apprv'd



Project: **Preston & South Ribble Flood Risk Management Scheme**
Drawing title: **Area 1B GA Plan Sheet 2 of 3**

Drawing status: **A5 - Authorised and accepted Stage 5** Suitability: **A5**
Scale: **1:200 @ A1** DO NOT SCALE

Jacobs No. **B550B008** Rev: **C02**
Client No. **ENV000009C**
Drawing number: **ENV000009C-JAC-ZZ-41B-DR-C-0002**

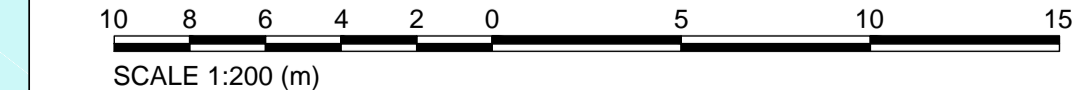

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SAFETY, HEALTH, ENVIRONMENTAL, AND WELFARE INFORMATION

IN ADDITION TO THE HAZARDS / RISKS NORMALLY ASSOCIATED WITH THE TYPES OF WORK DETAILED ON THIS DRAWING, NOTE THE FOLLOWING SIGNIFICANT RISKS:

CONSTRUCTION	DESCRIPTION
1X-4	Obstruction to emergency vehicle access.
1X-5	Potential ground contamination.
1X-12	Lighting column and lit sign.
1X-14	Intrusion within the working area.
1X-15	In-river works.
1A-8	Tidal variance in river water level.
1B-12	Interaction with pedestrians.
1B-16	Multiple services.
1B-27	Sensitive structure.

ENVIRONMENT	DESCRIPTION
1X-4	Obstruction to emergency vehicle access.
1X-5	Potential ground contamination.
1X-12	Lighting column and lit sign.
1X-14	Intrusion within the working area.
1X-15	In-river works.
1A-8	Tidal variance in river water level.
1B-12	Interaction with pedestrians.
1B-16	Multiple services.
1B-27	Sensitive structure.

IT IS ASSUMED THAT ALL WORKS WILL BE CARRIED OUT BY A COMPETENT CONTRACTOR WORKING, WHERE APPROPRIATE, TO AN APPROVED METHOD STATEMENT

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